

Planning Committee

03 May 2017



Application No:	17/00436/CPD						
Site Address:	135 Elizabeth Ave	135 Elizabeth Avenue, Laleham, TW18 1JN					
Proposal:	Certificate of lawfulness for the proposed development of loft alterations including the installation of rear facing dormer and three roof lights within the front elevation.						
Applicant:	Mr Mark Lunn						
Ward:	Staines South						
Call in details:	The applicants' wife is an officer employed by Spelthorne Borough Council, and Paragraph 4 of the Scheme of Delegation requires all applications by members and staff to be determined by the Planning Committee.						
Case Officer:	Matthew Churchil	l					
Application Dates:	Valid: 13.04.2017	Expiry: 11.05.2017	Target: Under 8 weeks				
Executive Summary:	A Lawful Development Certificate confirms whether the proposed works are 'Permitted Development' and therefore do not require planning permission. Decisions must be based only on the 'legal' position as set out in the Permitted Development Order, and are not assessed in terms of its relative planning merits.						
Recommended Decision:	defined by Part 1, Development Ord	Ild constitute permitte Schedule 2, of the 0 ler 2015 and plannin ficate of Proposed De	General Permitted g permission is not				

1. <u>Development Plan</u>

1.1 This Lawful Development Certificate (LDC) seeks to establish whether the dormer proposed within the rear elevation of the dwelling, and three rooflights proposed within the front roof slope, would constitute 'Permitted Development' and would not therefore require planning permission. The purpose of such Certificates is to provide the Council's formal confirmation that planning permission would not be required. Such proposals have to be assessed solely against the criteria set out in the General Permitted Development Order 2015.

2. <u>Description of Current Proposal</u>

- 2.1 The application site is occupied by a two storey mid-terraced dwelling located on the southern side of Elizabeth Avenue, Laleham. The property contains an existing single storey rear extension, and is located within the 1 in 1000 year flood event area. The property also contains off-street parking at the front of the dwelling. The proposal seeks to erect a dormer within the rear elevation and three rooflights within the front roof slope.
- 2.2 Copies of the site layout and elevations are provided as an Appendix.

Consultations

3. The following table shows those bodies consulted and their response.

Consultee	Comment
Environmental Health	No objection

4 Assessment of Application

- 4.1 The proposed dormer within the rear elevation, and three roof lights within the front elevation would constitute permitted development, as specified in Part 1, Schedule 2, Class B (in relation to the dormer) and Class C (in relation the roof lights) of the General Permitted Development Order 2015.
- 4.2 In relation to Class B (the dormer), the roof would not exceed the highest part of the existing roof; would not extend beyond the plane of any existing roof slope which forms the principal elevation of the dwellinghouse and fronts a highway; the cubic content of the resulting roofspace would not exceed the cubic content of the original roof space by more than 40 cubic metres; would not consist of or include the construction or provision of a veranda, balcony or raised platform or the installation, alteration or replacement of a chimney, flue or soil and vent pipe.

4.3 In relation to Class C, the proposed roof lights would not protrude more than 150 millimetres beyond the plane of the roof slope when measured from the perpendicular with the external surface of the original roof.

5 <u>Reccommendation</u>

5.1 The proposed rear dormer and rooflights on the front of the property constitute permitted development and planning permission is not required. The Lawful Development Certificate should be issued subject to the 'conditions' set out in the Order which in the case of Condition 1, reflect the standard

qualifications/limitations specified in the General Permitted Development Order.

Conditions

1. The proposed dormer roof extension would constitute permitted development under the terms of Class B Part 1, Schedule 2 of the Town and Country Planning (General Permitted Development) Order 2015 subject to the following conditions as set out in the order:

(a) the materials used in any exterior work shall be of a similar appearance to those used in the construction of the exterior of the existing dwellinghouse;

(b) other than in the case of a hip-to-gable enlargement, the edge of the enlargement closest to the eaves of the original roof shall, so far as practicable, be not less than 20 centimetres from the eaves of the original roof;

(c) any window inserted on a wall or roof slope forming a side elevation of the dwellinghouse shall be --


(i) obscure glazed, and

(ii) non-opening unless the parts of the window can be opened are more than 1.7 metres above the floor of the room in which the window is installed.


2. The proposed roof lights that would be situated within the front elevation would meet the requirements of Schedule 2 Part 1 Class C of the Town and Country Planning Act (General Permitted Development) 2015.

Informatives


1. The applicant's attention is drawn to the requirements of the Party Wall etc. Act 1996 in relation to work close to a neighbour's building/boundary.

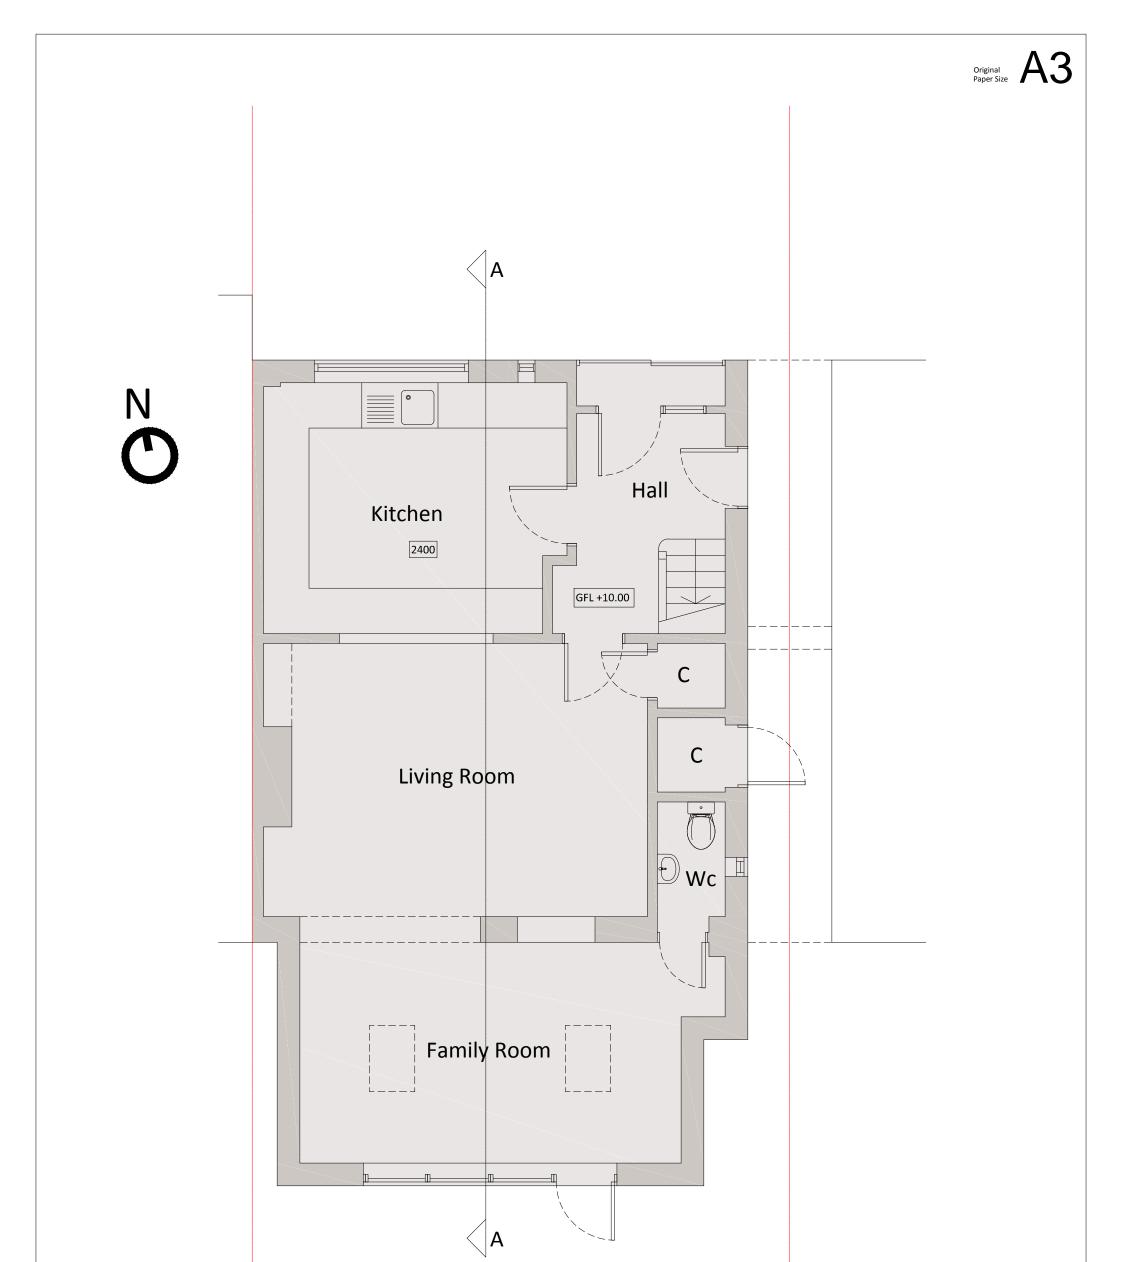


PLANNING	Job 135 Elizabeth Avenue Staines	Drawing Existing Ground Floor P		Floor Pla	an	
Scale 1:50 0 2m	Surrey TW18 1JN					
	Number Re	vision	Scales	Date	Drawn	Checked
	EX02		1:50	03.2017		

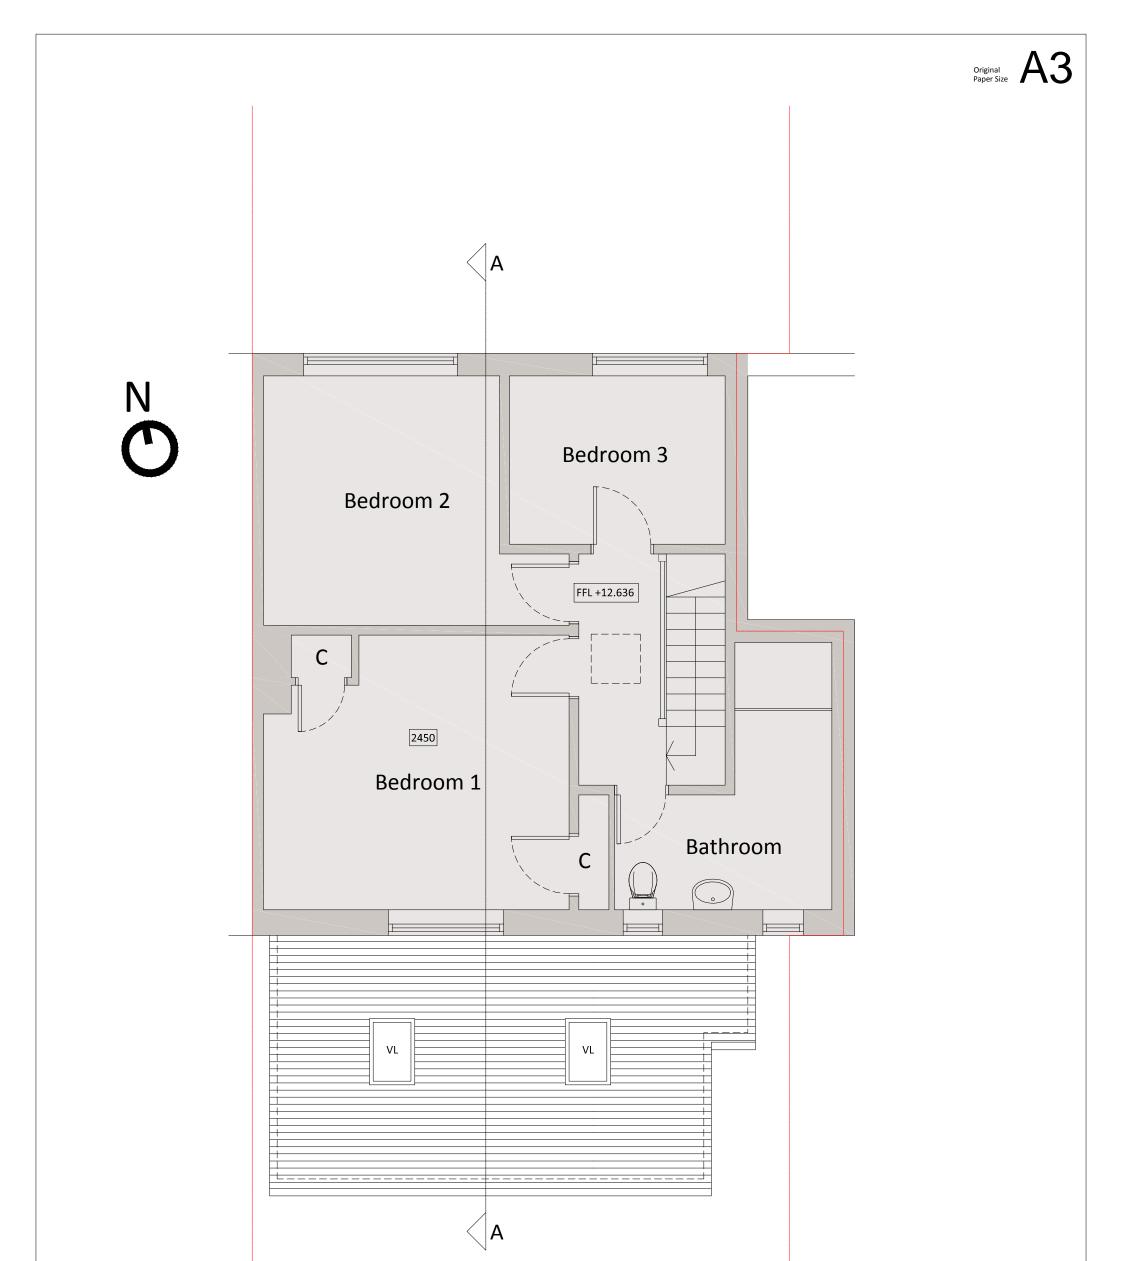


PLANNING	Job 135 Elizabeth Avenue Staines		Drawing Existing First Floor Plan			
Scale 1:50 0 2m	Surrey TW18 1JN					
	Number	Revision	Scales	Date	Drawn	Checked
	EX03		1:50	03.2017		

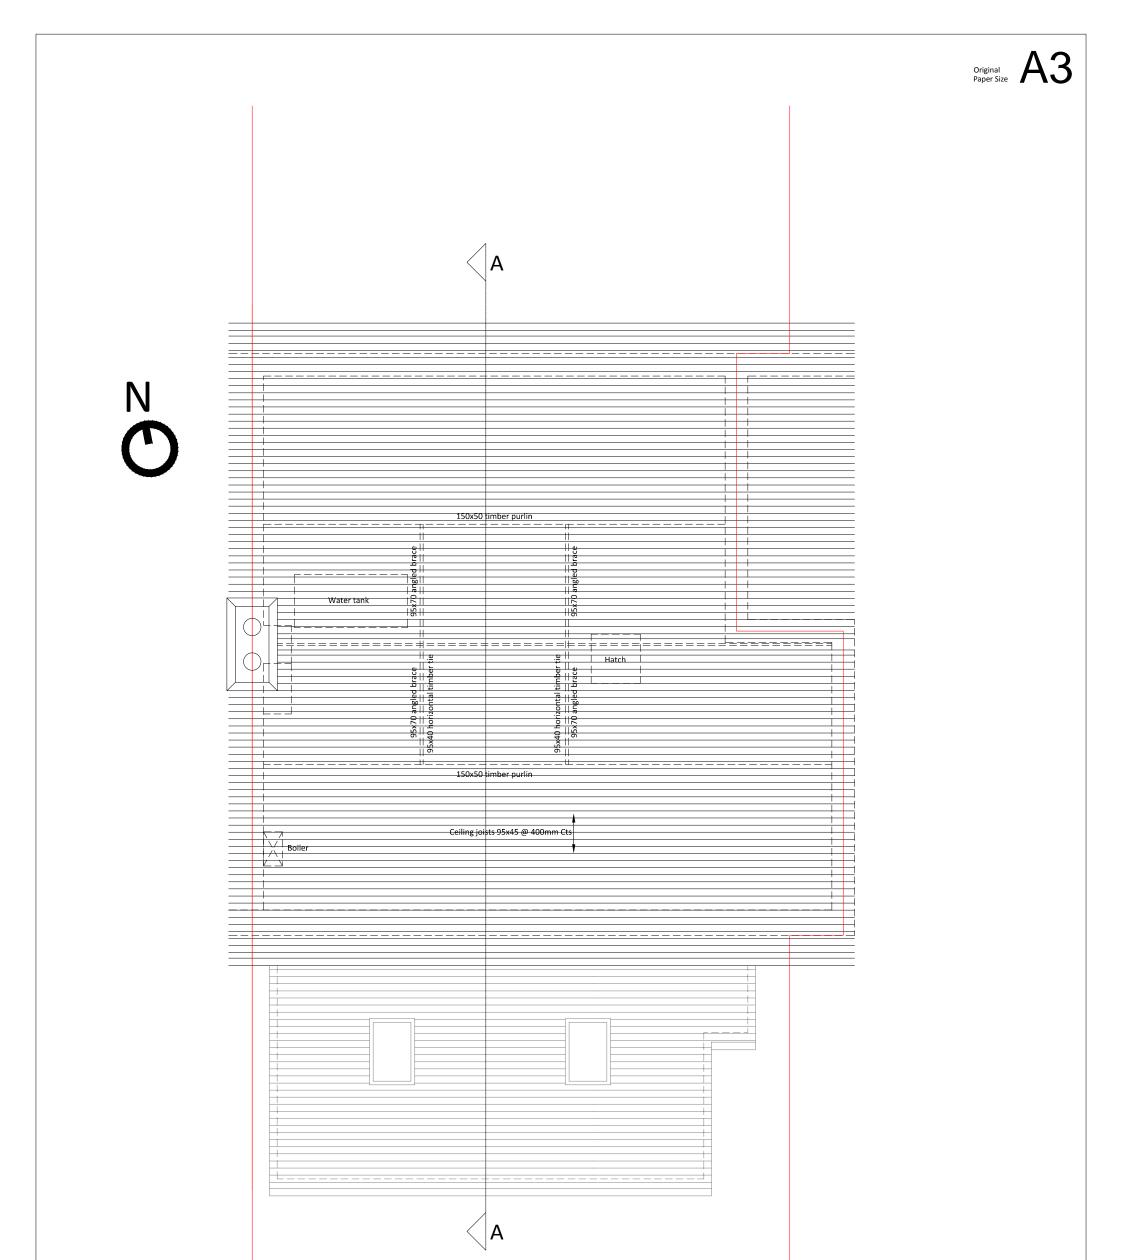

PLANNING	Job 135 Elizabeth Avenue Staines		Drawing Existing Roof Plan			
Scale 1:50 0 2m	Surrey TW18 1JN					
	Number	Revision	Scales	Date	Drawn	Checked
	EX04		1:50	03.2017		

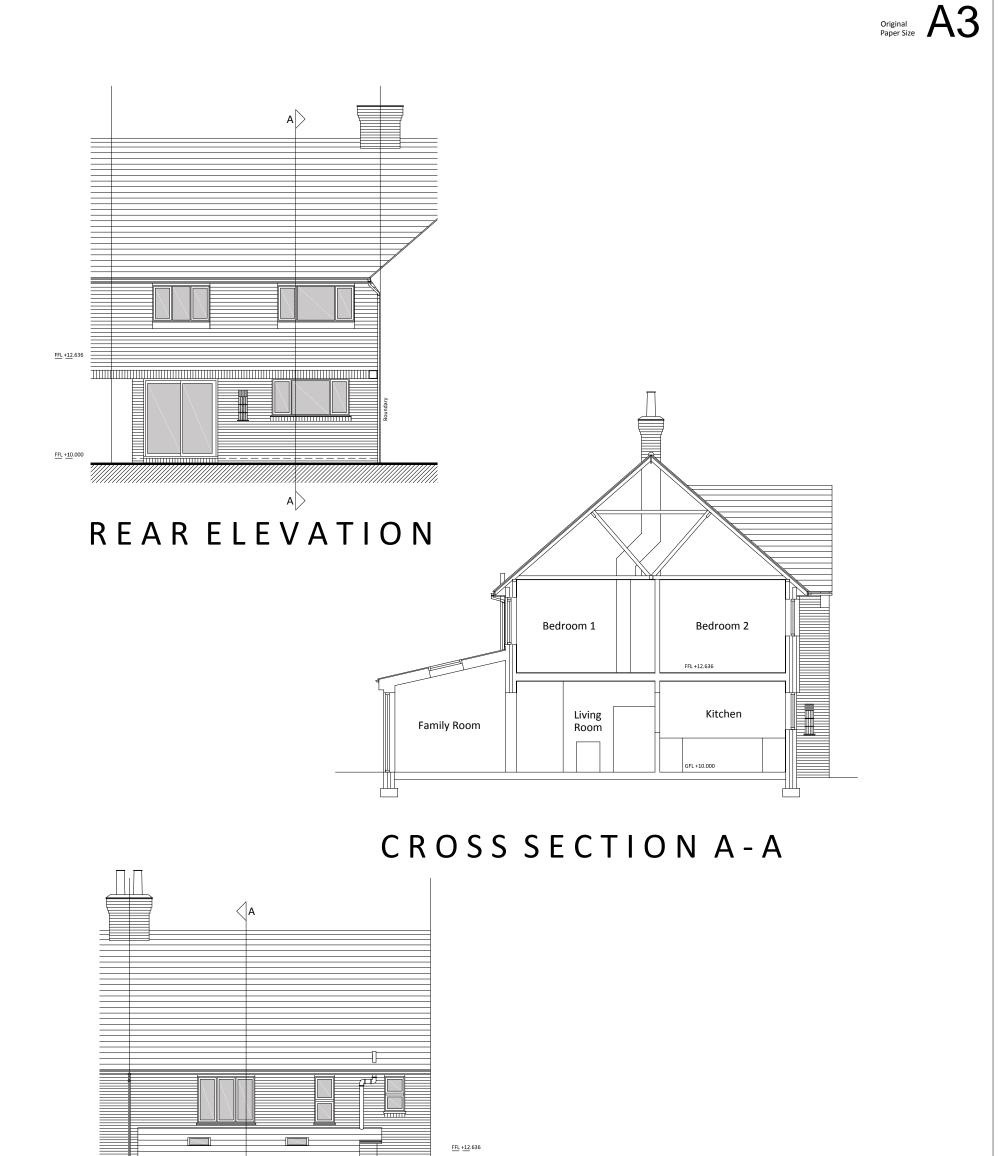


	<u>FFL +10.000</u>	
REAR ELEVATION	(Elizabeth Avenue)	
PLANNING Scale 1:100 0 5m	Job 135 Elizabeth Avenue Staines Surrey TW18 1JN	Drawing Existing Elevations & Cross Section A-A
	Number Revision	ScalesDateDrawnChecked1:5003.2017

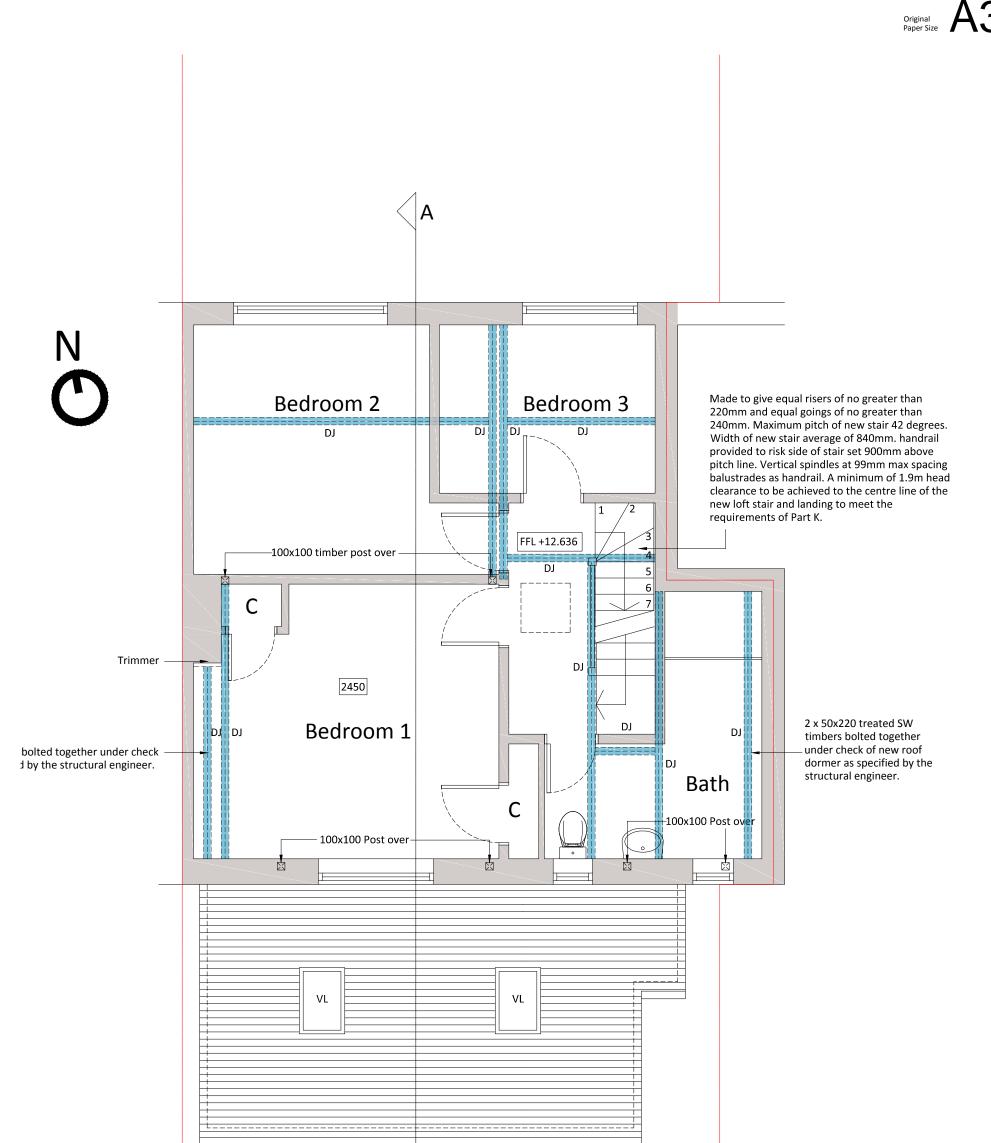

	Job 135 Elizabeth Avenue	Drawing Proposed First Floor Plan
PLANNING	Staines	
Scale 1:50 0 2m	Surrey TW18 1JN	
	Number Revisio	n Scales Date Drawn Checked
	P02	1:50 03.2017

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PLANNING	Job 135 Elizabeth Avenue		Drawing Proposed	d Second	d Floor F	Plan
FLAMMING	Staines					
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	Number	Revision	Scales	Date	Drawn	Checked
	P03		1:50	03.2017		

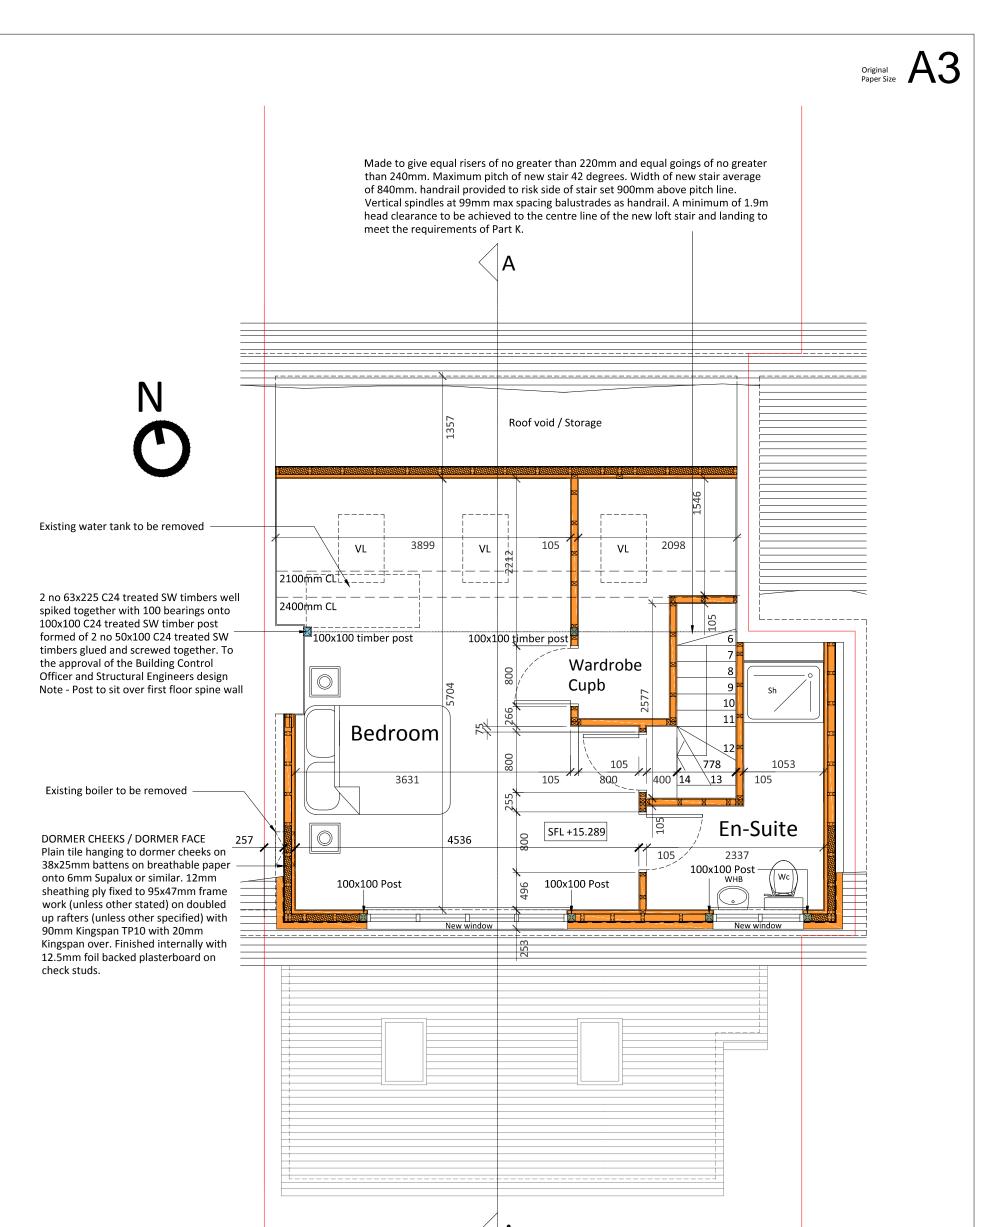
N

2 no 63x225 C24 treated SW timbers well spiked together with 100 bearings onto 100x100 C24 treated SW timber post formed of 2 no 50x100 C24 treated SW timbers glued and screwed together. To the approval of the Building Control Officer and Structural Engineers design Note - Post to sit over first floor spine wall


DORMER FLAT ROOF CONSTRUCTION 3 layer built up felt roofing system onto 126mm of Celotex TD4126, 18mm exterior grade plywood onto tapered firings (1:40 fall) min 25mm depth, onto treated softwood joists 50x150 C24@ 400mm Cts as specified by the structural engineer. New roof volume 35m³

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100x100 post b	elów,	100x100 post below 100x100 post	below 100×100 post below
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PLANNING	Job Drawing 135 Elizabeth Avenue Proposed Roof Plan Staines Surrey		lan			
Scale 1:50 0 2m	TW18 1JN Number	Revision	Scales	Date	Drawn	Checked
	P04		1:50	03.2017		

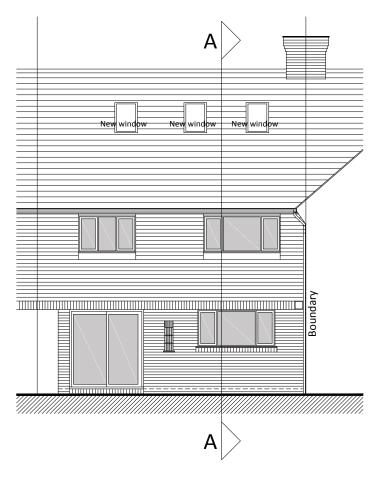


REAR ELEVATION

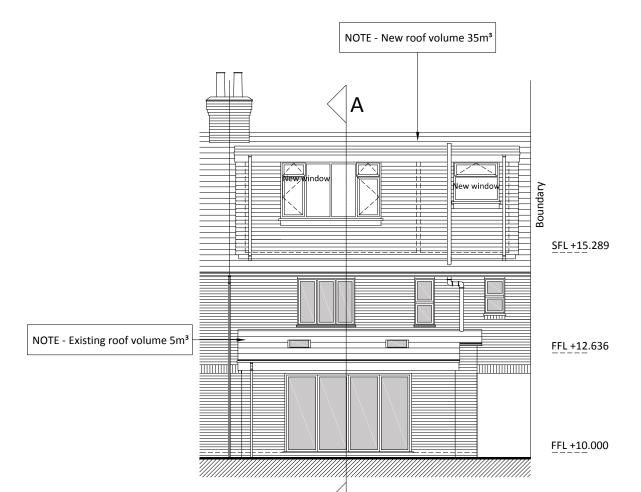


REAR ELEVATION (Elizabeth Avenue)

PLANNING	JobDrawing135 Elizabeth AvenueProposed ElevationsStainesSurrey		ons			
Scale 1:100 0 5m	TW18 1JN					
	Number P05	Revision	Scales 1:100	Date 03.2017	Drawn	Checked

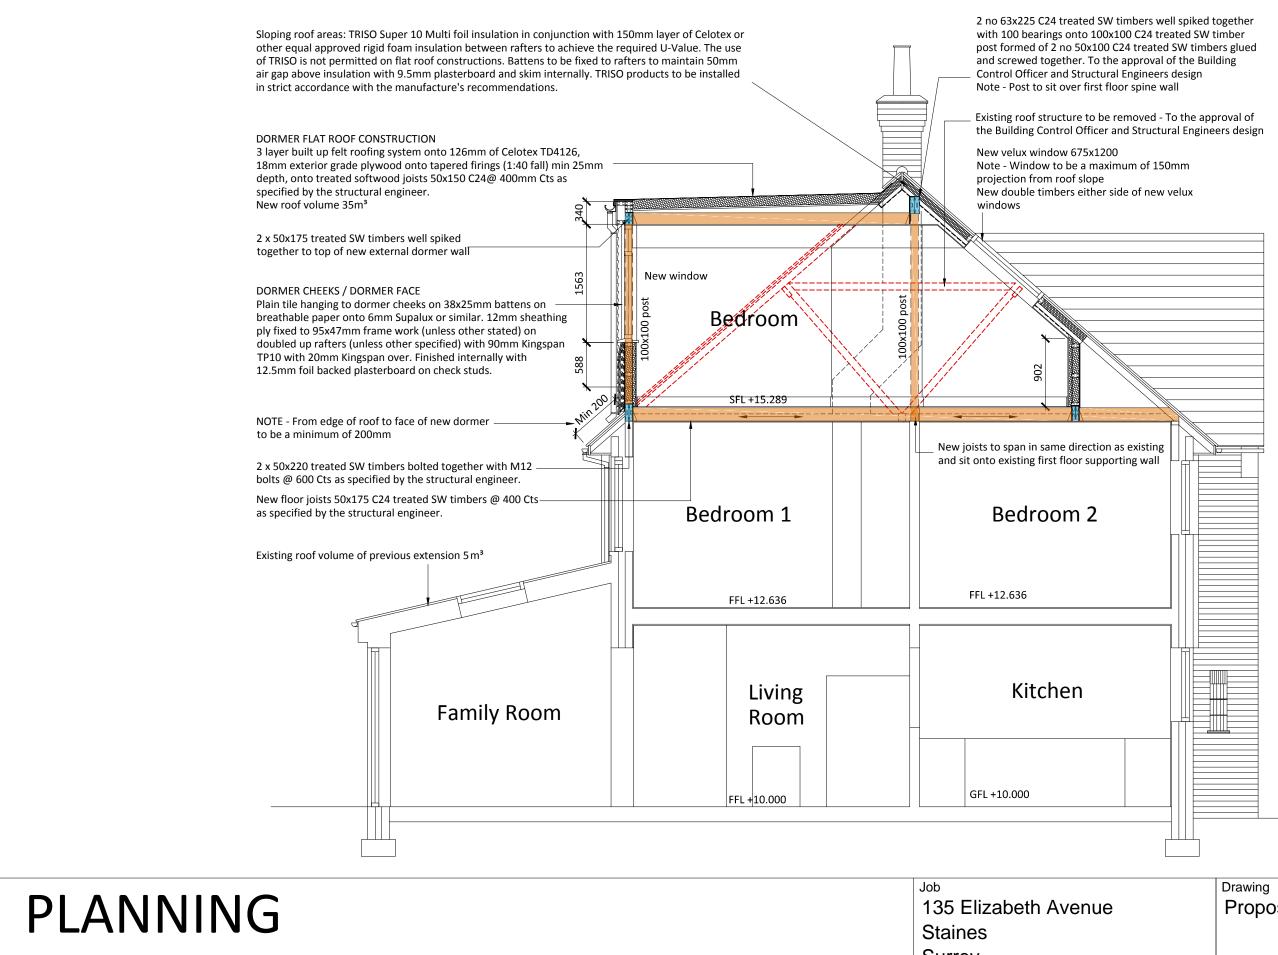

Scale 1:	50		
0		2	m

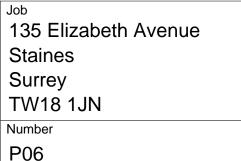

	Drawing Proposed Cross Section A-A			
Revision	Scales 1:100	Date 03.2017	Drawn	Checked

